
DOWELL AVENUE

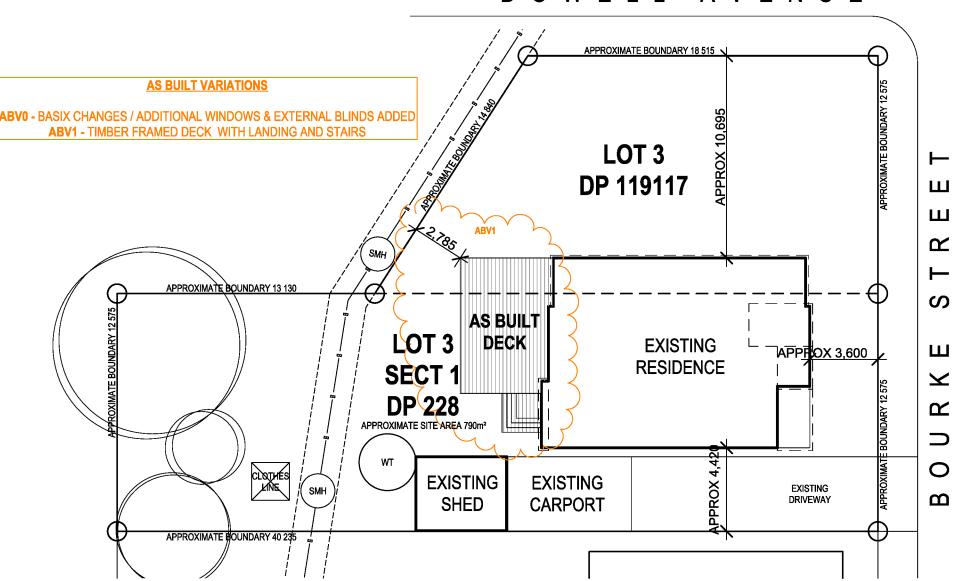

BASIX COMMITMENTS

PLUMBING FIXTURES

NEW/ALTERED SHOWER HEADS MAXIMUM FLOW 9 LITRES PER MINUTE

3 STAR NEW/ALTERED TOILET FLUSHING SYSTEM

MAXIMUM FLOW 4 LITRES PER FLUSH 3 STAR NEW/ALTERED TAPS 3 STAR MAXIMUM FLOW 9 LITRES PER MINUTE

HOT WATER

THE APPLICANT MUST INSTALL A GAS INSTANTANEOUS HOT WATER UNIT IN THE DEVELOPMENT

ARTIFICIAL LIGHTING

THE APPLICANT MUST ENSURE THAT 40% OF THE NEW OR ALTERED LIGHTING IS FLUORESCENT, COMPACT FLUORESCENT OR LED AS OUTLINED IN THE BASIX CERTIFICATE

THERMAL COMFORT

EXTERNAL FRAMED WALLS

-TO HAVE ADDITIONAL INSULATION OF R1.7 RATING OR HIGHER FLOOR ABOVE AN EXISTING DWELLING

CEILINGS UNVENTILATED DARK ROOF(SOLAR ABSORBANCE >0.70) -TO HAVE ADDITIONAL INSULATION OF R3.0 RATING -ROOF TO HAVE FOIL/SARKING INSTALLED



PROJECTS

ALL BUILDING WORK SHALL BE CARRIED OUT IN ACCORDANCE WITH THE BUILDING CODE OF AUSTRALIA.

PROVIDE LIFT OFF HINGES TO WC DOORS IN ACCORDANCE WITH THE BUILDING CODE OF AUSTRALIA.

PROVIDE DOWN PIPES IN ACCORDANCE WITH THE BUILDING CODE OF AUSTRALIA & AS2180 METAL RAINWATER GOODS.

PROVIDE WATERPROOFING SYSTEM TO ALL WET AREAS IN PROVIDE WATER/PROVINGS 37518M TO ALL WET ARCAS IN ACCORDANCE WITH PART F1-7 FOR COMMERCIAL PREMISES OF THE BUILDING CODE OF AUSTRALIA. PROVIDE WATER/PROOFING SYSTEM TO ALL WET AREAS IN ACCORDANCE WITH CLAUSE 3.8.1 OF THE BUILDING CODE & AS3740

PROVIDE TIE DOWN AND BRACING IN ACCORDANCE WITH AS1684.2 AND STRUCTURAL ENGINEERS RECOMMENDATIONS

INSULATION MUST BE INSTALLED IN ACCORDANCE WITH PART 3.12.11.1 OF THE BUILDING CODE OF AUSTRALIA.

ALL LEVELS ARE INDICATIVE AND SHOULD BE CONFIRMED.

WATER TANK

TIMBER POST

COLUMN TO ENG. DETAIL

SMOKE DETECTOR

BRICK PEIR

DEVELOPMENT NOTES

PROVIDE TERMITE PROTECTION IN ACCORDANCE WITH AS 3660.1

LEGEND

C1 OSD

THE DRIVEWAY CONSTRUCTION IS TO COMPLY WITH ABLE F OF ENGINEERING DESIGN GUIDE FOR UBDIVISIONS AND DEVELOPMENTS. ACCESSES ARE TO CROSS THE FOOTWAY PERPENDIC

NHOLE COVER OR MARKER, OR STREET TREE. ANY LOCATION, ALTERATION OR REPLACEMENT REQUIRED IALL BE IN ACCORDANCE WITH THE REQUIREMENTS OF


ALTERATIONS & ADDITIONS 72 BOURKE STREET TAMWORTH NSW 2340

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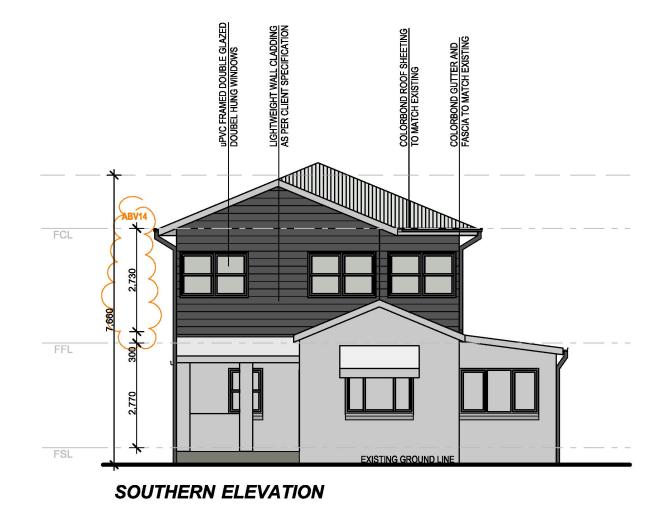
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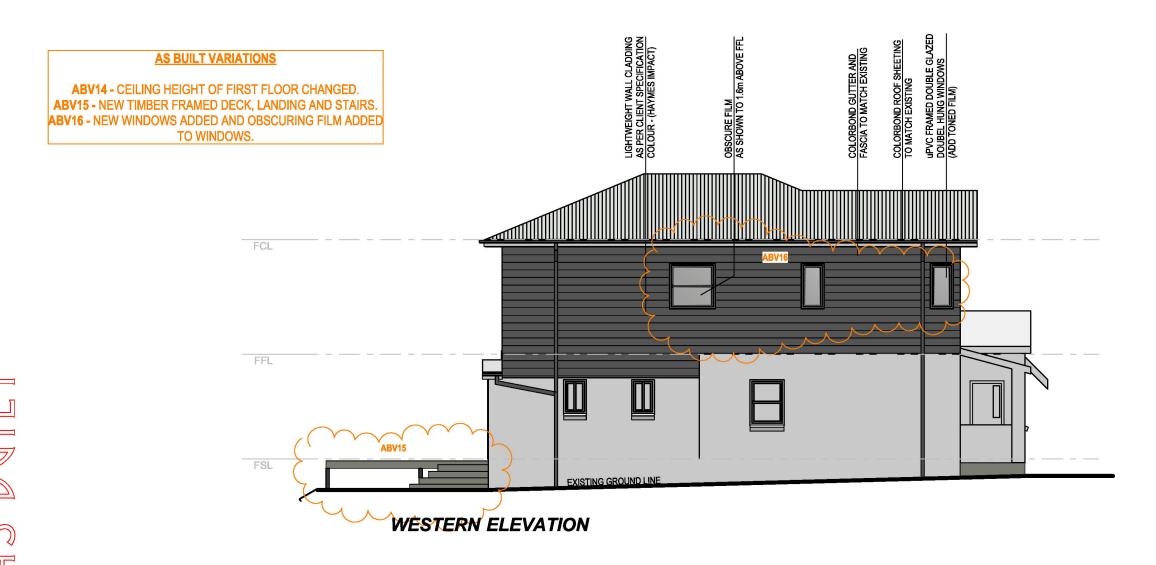
WINDOWS, GLAZED DOORS & SKYLIGHTS				
WINDOW NO.	ORIENTATION	AREA	TYPE OF WINDOW / FRAME / GLASS	SHADING
W06	w	0.72	TIMBER OR uPVC, CLEAR/AIR GAP/ CLEAR (U-VALUE:3.67, SHGC:0.59)	EAVE/VERANDAH/PERGOLA/BALCONY >=450
W07	w	0.72	TIMBER OR uPVC, CLEAR/AIR GAP/ CLEAR (U-VALUE:3.67, SHGC:0.59)	EAVE/VERANDAH/PERGOLA/BALCONY >=450
W13	E	1.44	TIMBER OR uPVC, CLEAR/AIR GAP/ CLEAR (U-VALUE:3.67, SHGC:0.59)	EXTERNAL LOUVRE/BLIND (ADJUSTABLE)
FD01	E	5.67	TIMBER OR uPVC, CLEAR/AIR GAP/ CLEAR (U-VALUE:3.67, SHGC:0.59)	EXTERNAL LOUVRE/BLIND (ADJUSTABLE)
FD02	N	9.52	TIMBER OR uPVC, CLEAR/AIR GAP/ CLEAR (U-VALUE:3.67, SHGC:0.59)	EXTERNAL LOUVRE/BLIND (ADJUSTABLE)

THE LEADING EDGE OF EACH EAVE, PERGOLA, VERANDAH OR BALCONY MUST BE NO MORE THAN 500 ABOVE THE HEAD OF THE WINDOW OR GLAZED DOOR, EXCEPT THAT A PROJECTION GREATER THAN 500 AND UP TO 1500 ABOVE THE HEAD MUST BE TWICE THE VALUE IN THE TABLE.



COLOUR SCHEDULE		
FEATURE	COLOUR	SAMPLE
CLADDING	HAYMES (IMPACT)	more. And
FASCIA & GUTTER	COLORBOND (SHALE GREY)	Shale Grey™
ROOF SHEETING	COLORBOND (SHALE GREY)	Shale Grey™
WINDOW FRAME & CASING	HAMES (CHALKY WHITE)	Chalky White

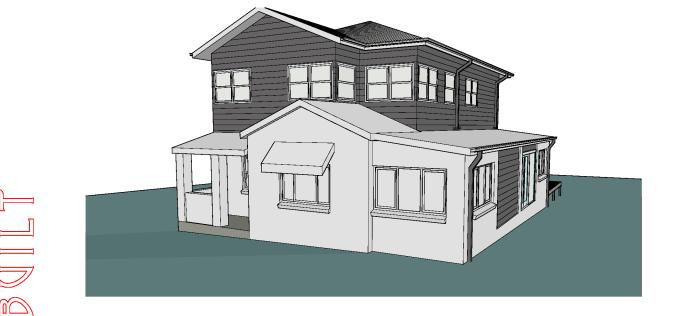





DEVELOPMENT NOTES

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PROVIDE LIFT OFF HINGES TO WC DOORS IN ACCORDANCE WITH THE BUILDING CODE OF AUSTRALIA.

ACCORDANCE WITH THE BUILDING COUDE OF AUSTRALIA.

PROVIDE WATERPROPING SYSTEM TO ALL WET AREAS IN
ACCORDANCE WITH PART F1-7 FOR COMMERCIAL PREMISES
OF THE BUILDING CODE OF AUSTRALIA. PROVIDE
WATERPROPING SYSTEM TO ALL WET AREAS IN
ACCORDANCE WITH CLAUSE 3.8.1 OF
THE BUILDING CODE & AS3740

PROVIDE TERMITE PROTECTION IN ACCORDANCE WITH AS 3660.1

PROVIDE TIE DOWN AND BRACING IN ACCORDANCE WITH AS1684.2 AND STRUCTURAL ENGINEERS RECOMMENDATIONS

INSULATION MUST BE INSTALLED IN ACCORDANCE WITH PART 3.12.11.1 OF THE BUILDING CODE OF AUSTRALIA.


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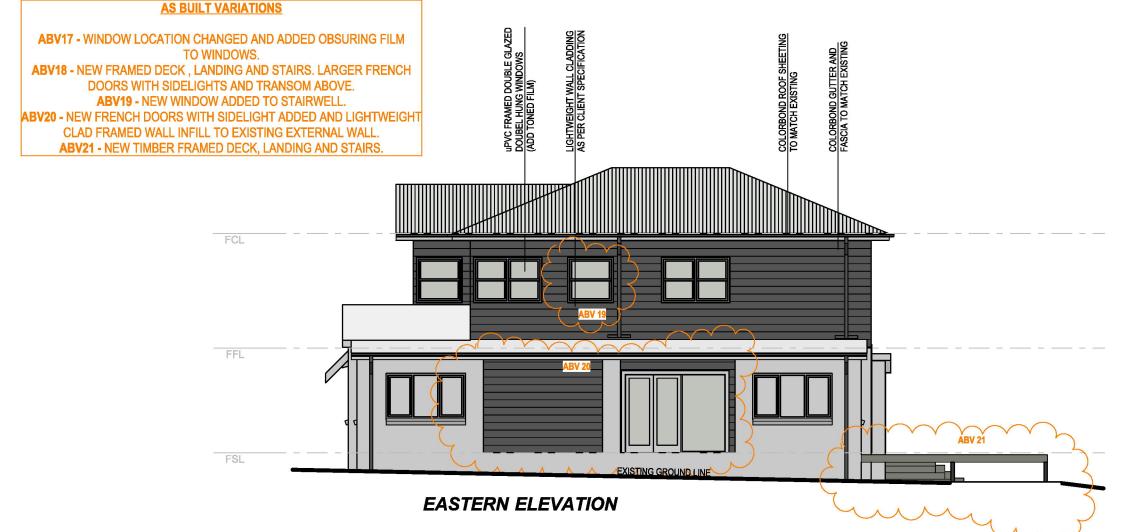
ALTERATIONS & ADDITIONS
72 BOURKE STREET
TAMWORTH NSW 2340

Drawing Title: ELEVATIONS

Status: AS BUILT	Scale: 1:100 @ A3	
Project No:	Sheet No.:	
14104	4 OF 7	

COLOUR SCHEDULE		
FEATURE	COLOUR	SAMPLE
CLADDING	HAYMES (IMPACT)	weet Age
FASCIA & GUTTER	COLORBOND (SHALE GREY)	Shale Grey™
ROOF SHEETING	COLORBOND (SHALE GREY)	Shale Grey™
WINDOW FRAME & CASING	HAMES (CHALKY WHITE)	Chalky White #925



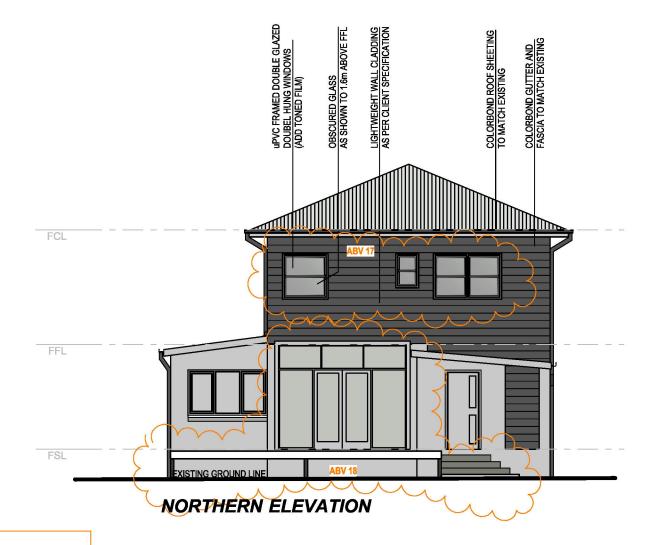



DEVELOPMENT NOTES

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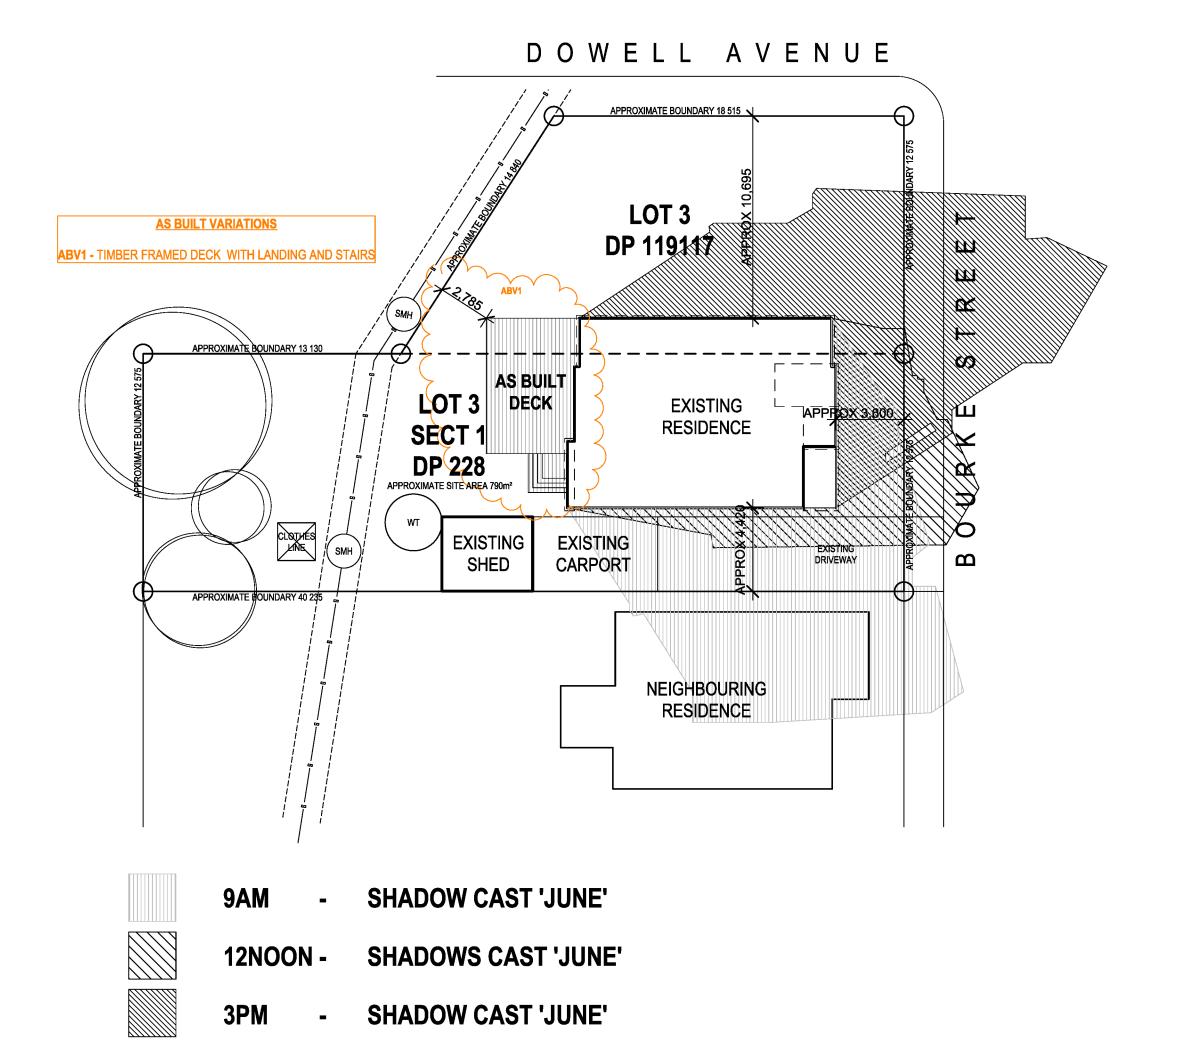
INSULATION MUST BE INSTALLED IN ACCORDANCE WITH PART 3.12.11.1 OF THE BUILDING CODE OF AUSTRALIA.

ALL LEVELS ARE INDICATIVE AND SHOULD BE CONFIRMED.

ALTERATIONS & ADDITIONS 72 BOURKE STREET TAMWORTH NSW 2340

Drawing Title: ELEVATIONS

Status: AS BUILT Scale: 1:100 @ A3 14104 5 OF 7





10	19/02/25	AS BUILT PLAN
11	20/02/25	AS BUILT PLAN
12	24/02/25	AS BUILT PLAN

DEVELOPMENT NOTES

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LEGEND

WATER TANK TIMBER POST BRICK PEIR

COLUMN TO ENG. DETAIL SMOKE DETECTOR



ALTERATIONS & ADDITIONS 72 BOURKE STREET TAMWORTH NSW 2340

Drawing Title: SUN STUDY

Status: AS BUILT	Scale: 1:200 @ A3
Project No:	Sheet No.:
14104	7 OF 7